



## State of Wisconsin \ DEPARTMENT OF NATURAL RESOURCES

Tommy G. Thompson, Governor  
George E. Meyer, Secretary  
William R. Selbig, Regional Director

Oshkosh Service Center  
905 Bay Shore Drive., P.O. Box 2565  
Oshkosh, Wisconsin 54903  
TELEPHONE 920-424-3050  
FAX 920-424-4404

September 3, 1999

Ms. Eileen Golliher  
C/o Mr. Jack Oneil  
711 S. Main St.  
Westfield WI 53964

SUBJECT: Closure of Former Golliher Auto Service Facility  
205 North Main Street, Westfield WI  
WDNR BRRTS ID#03-39-002269

Dear Ms. Golliher:

The Department's Case Closeout Committee in the Northeast Region has completed a review of the above referenced petroleum contamination case. This panel reviews environmental remediation cases for compliance with state laws, standards, and guidelines to maintain consistency in the closeout of cases. It appears that actions have been taken to the extent practicable to restore the environment and minimize the harmful effects from this discharge to the air, lands and waters of this state. At this time, your site has been granted closure with the following condition.

**Closure Condition 1:** Written confirmation from the Village of Westfield that they have been made aware of the residual groundwater contamination above NR140 Enforcement standards for benzene at RW-3 at the intersection of Main and Spring streets and will insure that this information is added to the Villages Utility Plans. This confirmation may be in the form of a deed notification or letter signed by the Village Council and/or Village Attorney. I example groundwater use restriction is included to provide guidance in drafting this letter.

Based on the information available, the Department is not requiring any further investigation or other action concerning this specific site. However, if additional information in the future indicates that further investigation or cleanup is warranted, the Department will require appropriate action to be taken at that time (pursuant to s. NR 726.09, Wis. Admin. Code).

All monitoring wells, sumps, and/or boreholes must be abandoned according to Chapter NR 141, Wisconsin Administrative Code following completion of Closure Condition 1. The abandonment forms (#3300-5B) should be sent to my attention. Until this verification of proper abandonment is provided, the DNR will continue to track this facility as an active BRR site.

The Department appreciates the cooperation you have shown in this matter. Your concern for your property and the environment is commendable. If you have any questions please call me at



920-424-7890.

Sincerely,

A handwritten signature in black ink, appearing to read 'K. McKnight', with a long horizontal flourish extending to the right.

Kevin D. McKnight  
Hydrogeologist  
Bureau for Remediation and Development

Cc: file

Robert Klauk, P.O. Box 127, Kaukauna WI 54130-2404

SCRENOCK LAW OFFICE  
118 EAST 2ND STREET  
WESTFIELD, WISCONSIN 53964

PAUL STEVEN SCRENOCK, J.D.  
LICENSED IN WISCONSIN AND ILLINOIS  
CHARLENE J. CLARK, PARALEGAL



**R + R - OSH**  
**RECEIVED** September 28, 1999

OCT 11 1999

Mr. Kevin McKnight  
State of Wisconsin  
Department of Natural Resources  
905 Bay Shore Dr.  
P. O. Box 2565  
Oshkosh, WI 54903

**TRACKED** ☐  
**REVIEWED** ☐

RE: Closure of Golliher Auto  
Service Facility  
205 N. Main St., Westfield  
Wisconsin  
WDNR BRRTS ID#03-002269

Dear Mr. McKnight:

As Village Attorney for the Village of Westfield I am writing you concerning the above closure project. The property is located as a Public Right-of-Way at the intersection of Spring Street and Main St., Westfield, Marquette County, Wisconsin. Presently the Village of Westfield is the owner of the above described Right-of-Way.

The Village of Westfield is aware that a petroleum discharge has occurred at this property. Benzene contaminated groundwater above the ch. NR 140 enforcement standard exists on the property at the location of recovery well RW-3. Benzene remains at 7.4 micrograms per liter.


The Village of Westfield will responsibly dispose of soil and/or groundwater contamination encountered in the vicinity of RW-3 during utility or road construction projects in the future. There are no plans to construct any well in the vicinity of RW-3, where water quality needs to exceed the drinking water standards in ch. NR 809.

If you need anything further from this office feel free to contact us.

Sincerely,

Paul Steven Screnock  
State Bar #01017603

PSS/cjc  
cc: Linda Quinn, Village Secretary

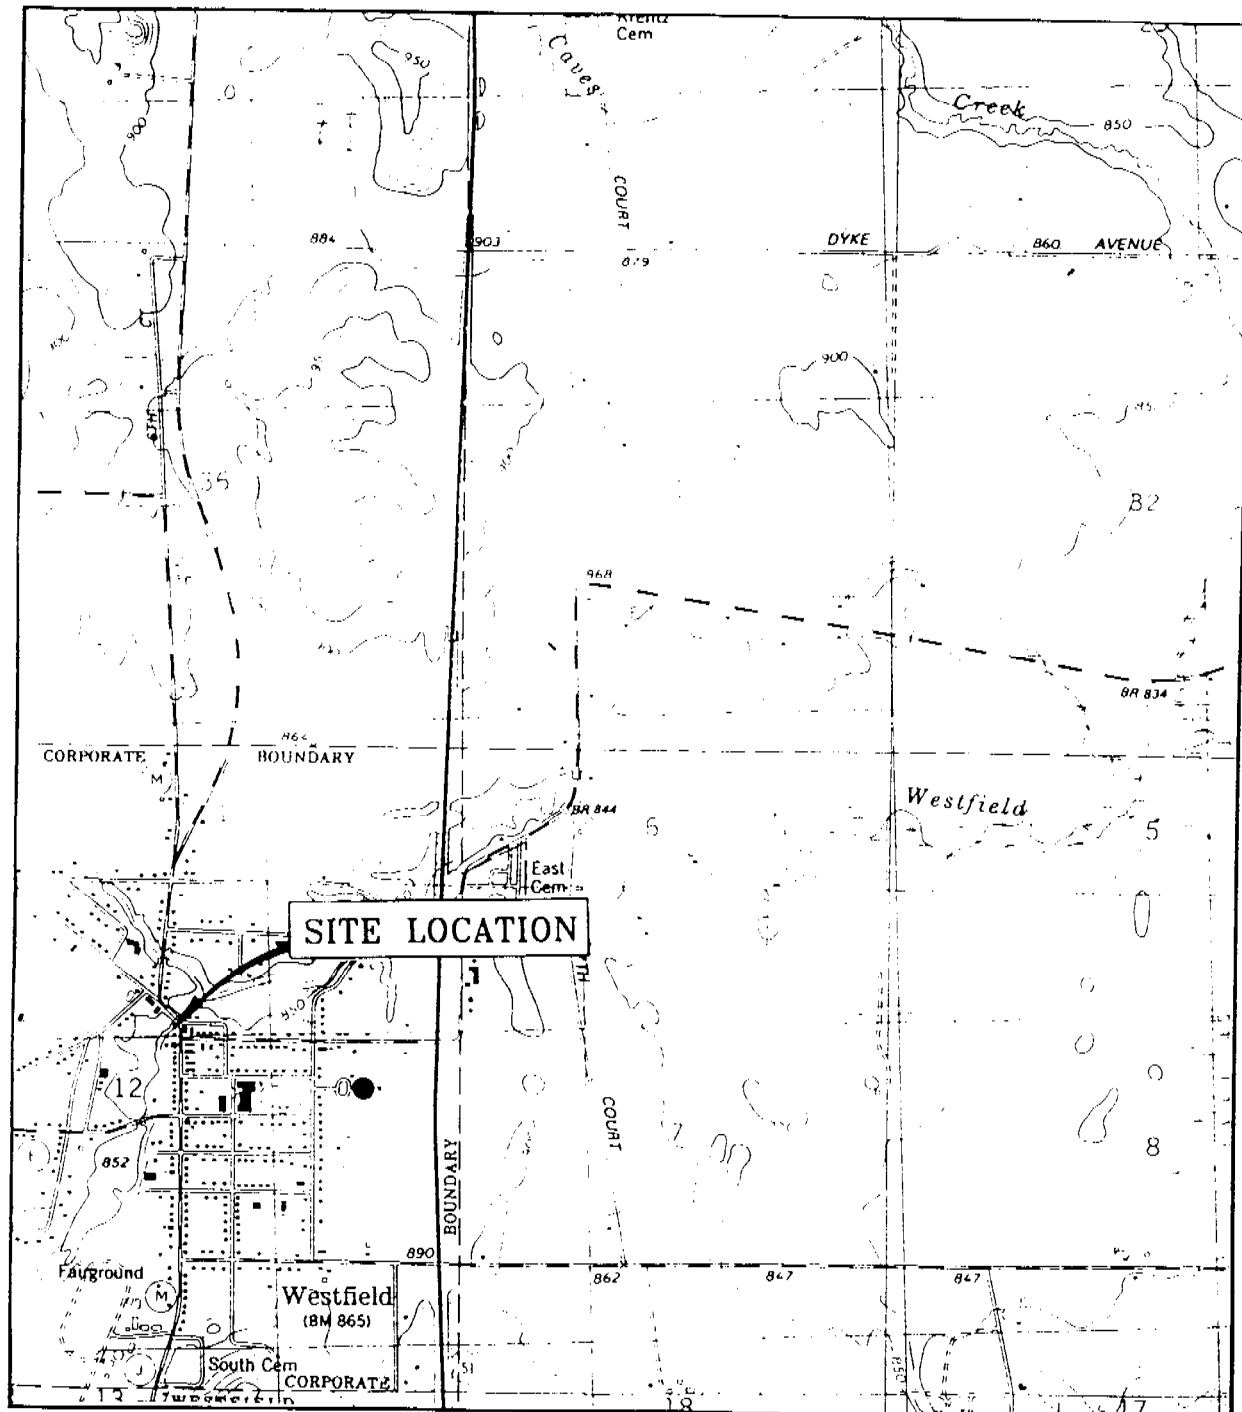

WESTFIELD EAST QUADRANGLE  
U.S.G.S. 7.5 MINUTE SERIES  
(TOPOGRAPHIC) MARQUETTE COUNTY  
WISCONSIN



SCALE: 1:24,000

FIGURE 1: SITE LOCATION MAP

**FISCHER**


RIPON OFFICE P.O. BOX 552, RIPON, WI 54971  
KAUKAUNA OFFICE P.O. BOX 127, KAUKAUNA, WI 54130

JOB #94051.002

DATE: 5/18/99

ID# 817161

GOLLIHER AUTO SERVICE  
WESTFIELD, WISCONSIN  
SITE INVESTIGATION

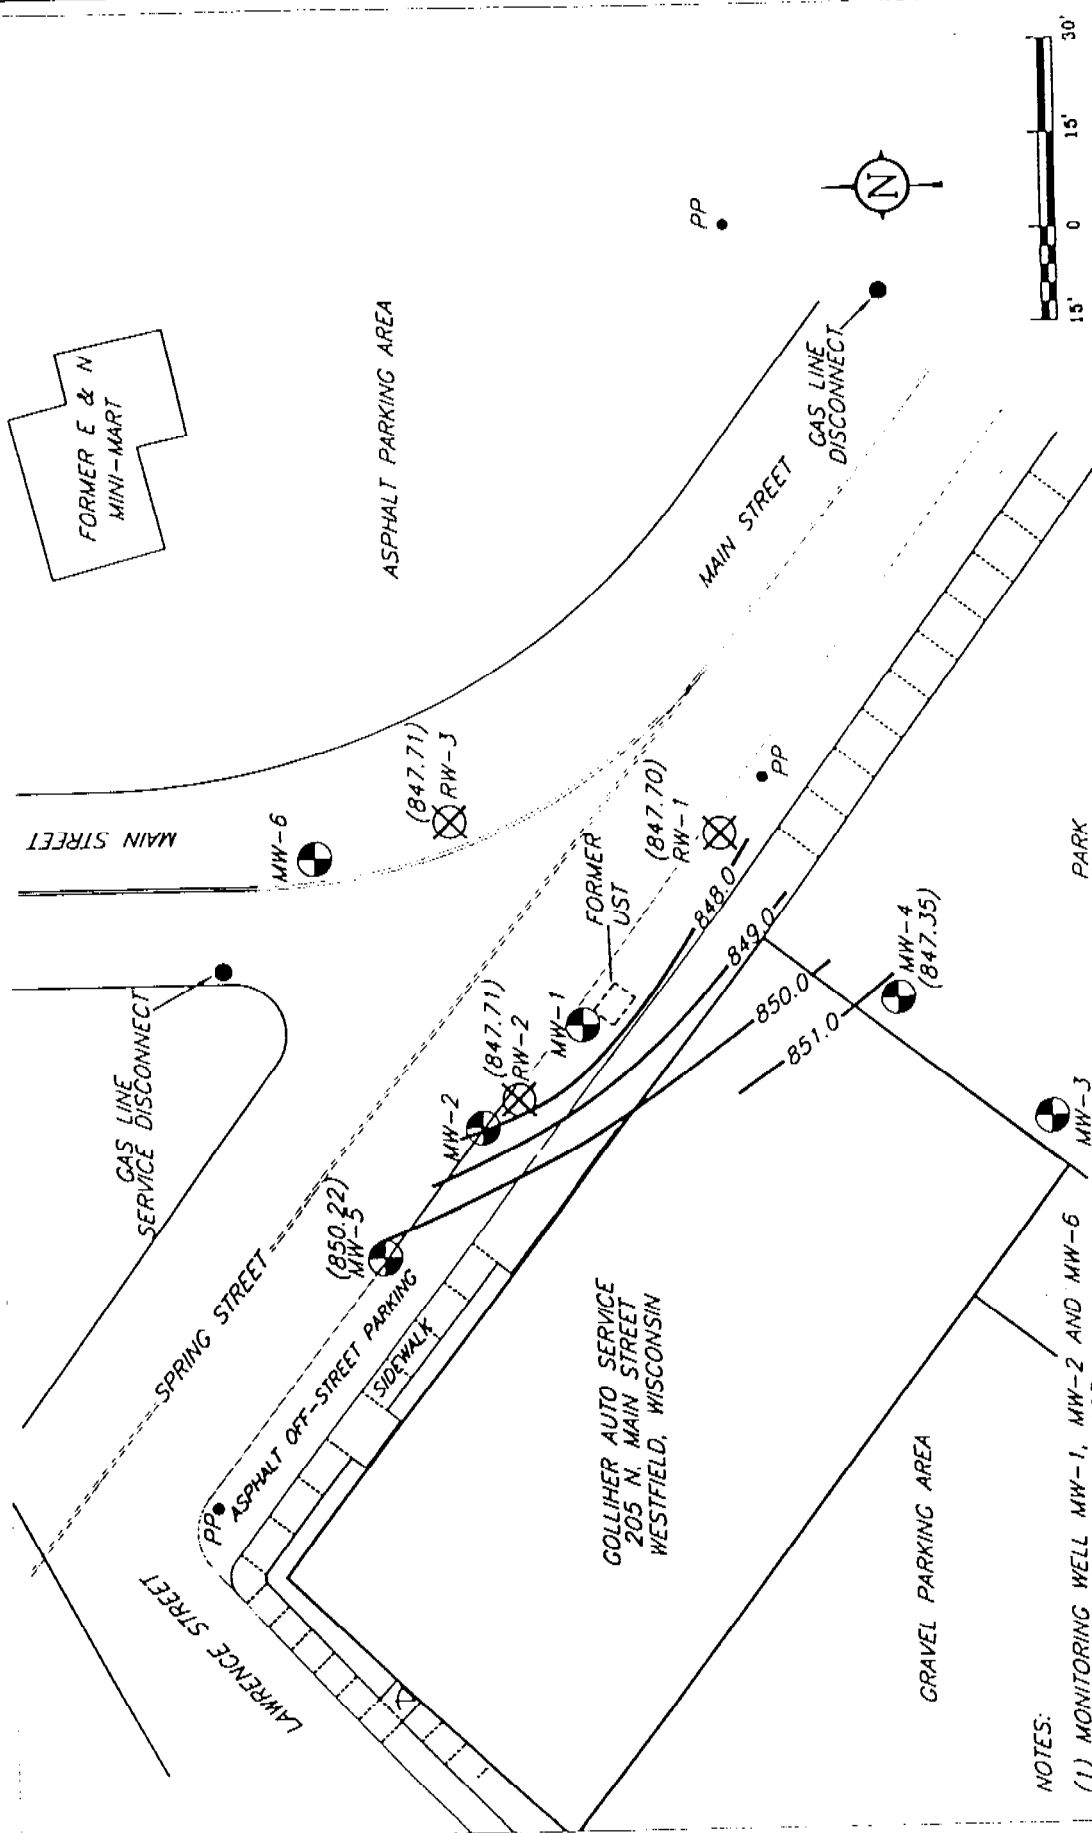

# NOTES:

- (1) MONITORING WELL MW-1, MW-2 AND MW-6 WERE REMOVED IN JULY 1997.
- (2) RECOVERY WELLS RW-1, RW-2 AND RW-3 WERE INSTALLED IN JULY 1997.
- (3) MW-3 WAS NOT INCLUDED IN GROUNDWATER FLOW DETERMINATION.

FIGURE 8: GROUNDWATER FLOW DIRECTION FOR NOVEMBER 5, 1998

RIPON OFFICE P.O. BOX 552 RIPON, WISCONSIN 54971		94051.003	
KAUKAUNA OFFICE P.O. BOX 127 KAUKAUNA, WI 54130		DRAWN BY: MD/KP	REVIEWED BY:
		DATE: 8/22/99	APPROVED BY:
		104. 8/1/01	

**FISCHER**

GOLLIHER AUTO SERVICE  
WESTFIELD, WISCONSIN  
CLOSURE REQUEST

**TABLE 4 (Continued)**  
**SUMMARY OF GROUNDWATER ANALYTICAL RESULTS**  
**FORMER GOLLIHER AUTO - FISCHER #94051.003**  
**WESTFIELD, WISCONSIN**

Monitoring Well		NR 140		RW-1				RW-2				RW-3			
Sampling Date		ES/PAL		9/11/97	12/11/97	8/20/98	11/5/98	9/11/97	12/11/97	8/20/98	11/5/98	9/11/97	12/11/97	8/20/98	11/5/98
PETROLEUM VOLATILE ORGANIC COMPOUNDS (PVOCS)+1,2-DCA+Naphthalene (µg/L)															
Benzene		5/0.5	0.59Q	0.60Q	<0.27	<0.27	<0.27	<0.41	<0.41	<0.27	<0.27	45	86	4.4	7.4
Ethyl Benzene		700/140	<0.23	<0.23	<0.32	<0.32	<0.32	<0.23	<0.23	<0.32	<0.32	67	44	0.96Q	4.8
Methyl tert-butyl ether		60/12	<0.53	<0.53	<0.32	<0.32	<0.32	<0.53	<0.53	<0.32	<0.32	<1.3	<1.1	<0.32	<0.32
Toluene		343/68.6	<0.28	<0.28	<0.27	<0.27	<0.27	<0.28	<0.28	<0.27	<0.27	140	<0.56	<0.27	0.40Q
1,2-Dichloroethane		5/0.5	<0.24	<0.24	<0.37	<0.37	<0.37	<0.24	<0.24	<0.37	<0.37	3.1	2.7	0.66Q	<0.37
Naphthalene		40/8	<0.66	<0.66	<0.35	<0.35	<0.35	<0.66	<0.66	<0.35	<0.35	44	22	<0.35	2.5
1,2,4-Trimethylbenzene		484/96	<0.55	<0.55	<0.49	<0.49	<0.49	<0.55	<0.55	<0.49	<0.49	560	214	<1.5	<9.1
1,3,5-Trimethylbenzene															
Xylenes		620/124	<0.79	<0.79	<0.67	<0.67	<0.67	<0.79	<0.79	<0.67	<0.67	650	72	1.32Q	<0.67
LEAD (µg/L)															
Lead		15/1.5	NA	NA	NA	NA	NA	NA	NA	NA	NA	NA	NA	NA	NA




NA = Parameter not analyzed

PAL - Preventive Action Limit


Q = Analyte detected above limit of detection (LOD) but below limit of quantitation (L ES - Enforcement Standard

µg/L = micrograms per liter

mg/L = milligrams per liter

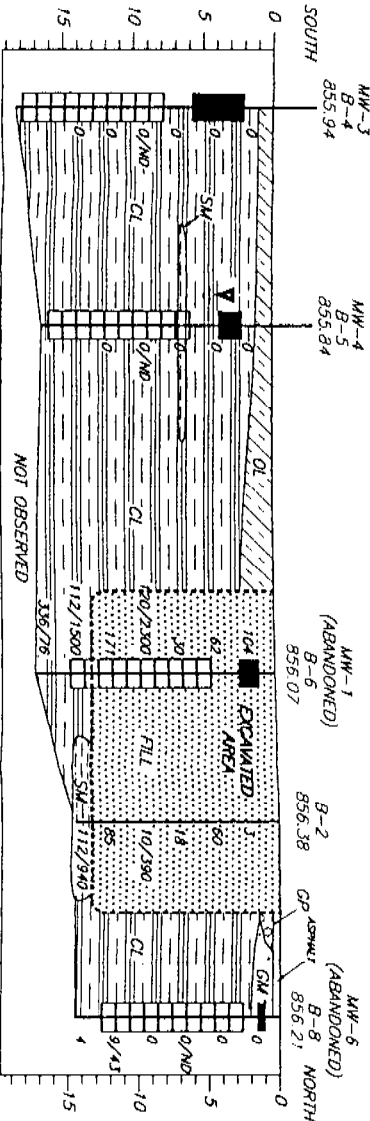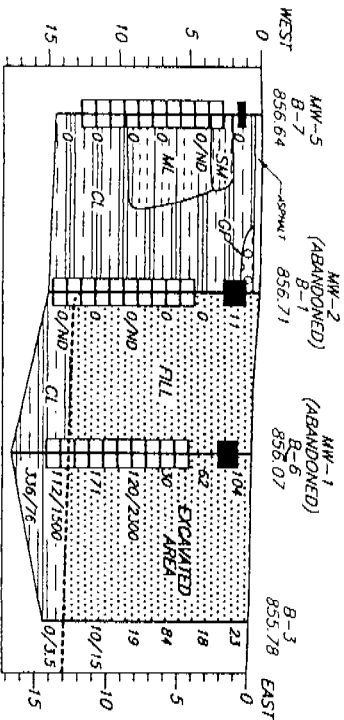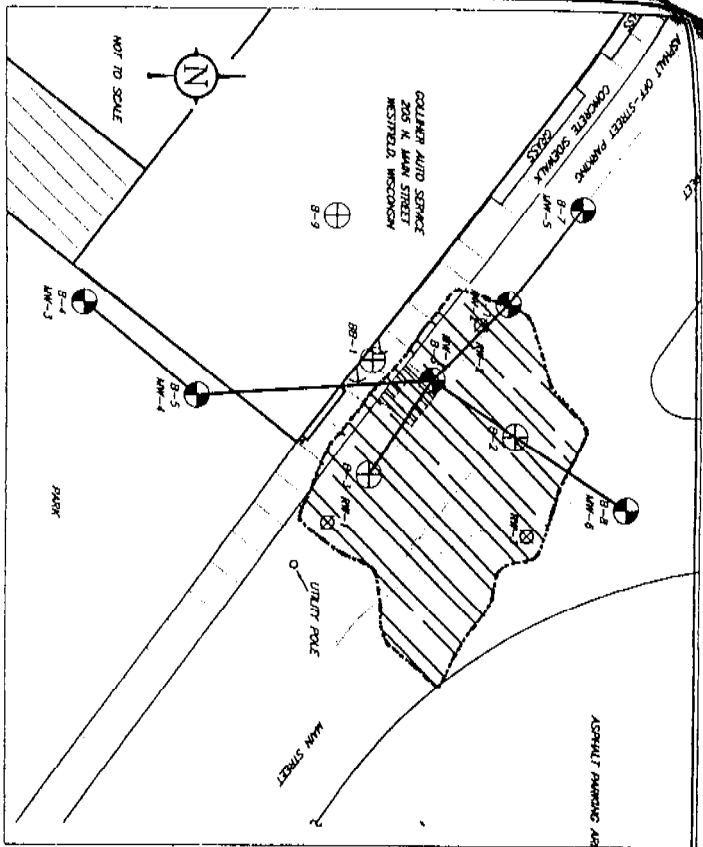

SCALE  
HORIZONTAL: 1" = 20'  
VERTICAL: 1" = 10'

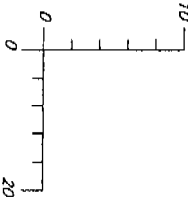

EXPLANATION	
SOILS CLASSIFICATION	MONITORING WELL
<p><b>FILL</b></p> <p>See bore logs</p> <p>Organic silts or silty clays of low plasticity.</p> <p>Inorganic clays of low to medium plasticity, gravelly clays, sandy clays, silty clays, lean clays.</p> <p>Silty sands, sand-silt mixtures.</p> <p>Inorganic silts, and very fine sands, rock flour, silty or clayey fine sand or clays with slight plasticity.</p> <p>Poorly graded gravels or gravel-sand mixtures, little or no fines.</p> <p>Silty gravels, gravel-sand-silt mixtures.</p> <p>Not observed</p>	<p>Bentonite Seal</p> <p>WATER LEVEL 11/5/98</p> <p>PIG/BENZENE</p> <p>Well Screen</p>


FIGURE 5: POST-REMEDIAL GEOLOGIC CROSS-SECTION

**FISCHER**



RIPON OFFICE P.O. BOX 552  
RIPON, WISCONSIN 54971  
KAUKAUNA OFFICE P.O. BOX 127  
KAUKAUNA, WISCONSIN 54130

94061.003	
DRAWN BY: MD/KP	REVIEWED BY:
DATE: 8/89/99	APPROVED BY:
ID# CLOSURE/CROSS-SECTION1	

GOLLIHER AUTO SERVICE  
WESTFIELD, WISCONSIN  
CLOSURE REQUEST

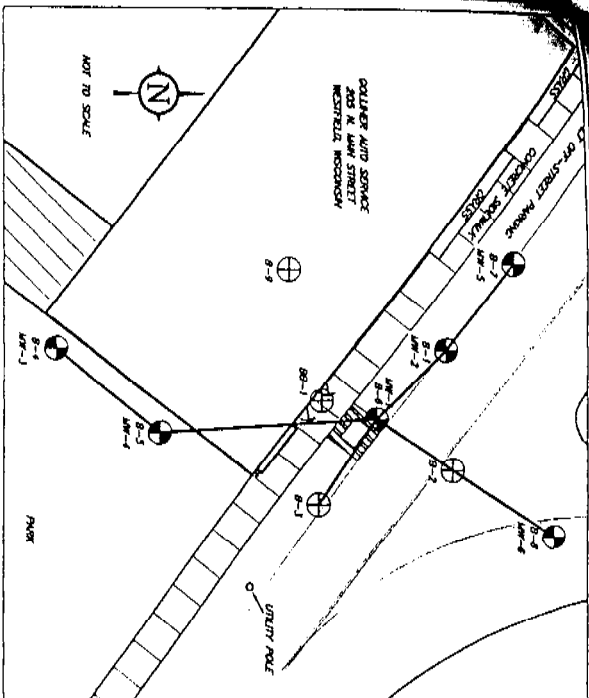

EXPLANATION	
SOILS CLASSIFICATION	MONITORING WELL
<p>OL Organic silts or silty clays of low plasticity.</p> <p>CL Inorganic clays of low to medium plasticity, poorly clayey, sandy clays, silty clays, lean clays.</p> <p>SM Silty sands, sand-silt mixtures.</p> <p>ML Inorganic silts, and very fine sands, rock struts, silty or clayey fine sand or clayey silts with slight plasticity.</p> <p>GP Poorly graded gravels or gravel-sand mixtures, little or no fines.</p> <p>GK Silty gravels, gravel-sand-silt mixtures.</p> <p>Not observed</p>	<p>Bentonite Seal</p> <p>WATER LEVEL</p> <p>6/12/97</p> <p>PH/BENZENE</p> <p>Well Screen</p>

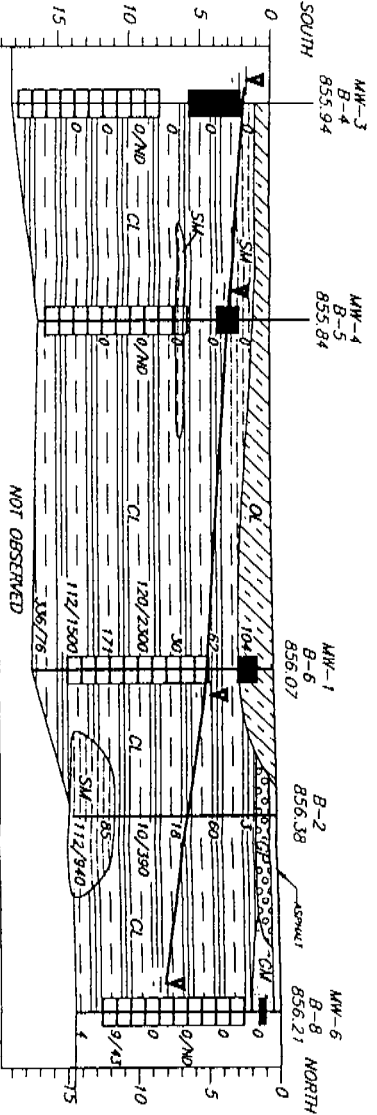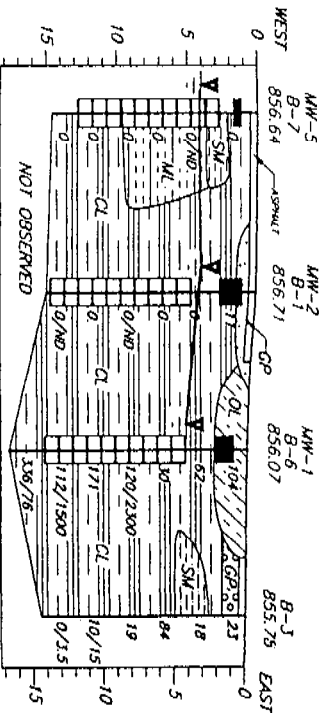

SCALE  
HORIZONTAL: 1" = 20'  
VERTICAL: 1" = 10'

FIGURE 3: PRE-REMEDIAL GEOLOGIC CROSS-SECTION

**FISCHER**

RIPON OFFICE P.O. BOX 552  
RIPON, WISCONSIN 54971  
KAUKAUNA OFFICE P.O. BOX 127  
KAUKAUNA, WISCONSIN 54130

94061.003	
DRAWN BY: MD/EP	REVIEWER: ET
DATE: 6/25/99	APPROVED BY:
15th CLOSURE/CLOSURE SECTION	

GOLIHER AUTO SERVICE  
WESTFIELD, WISCONSIN  
CLOSURE REQUEST